


|                        |                       |
|------------------------|-----------------------|
| SDS SKETCH FOR: Peters | JOB NO.: 102508       |
| MAP: 16                | DRAWING NO.: 102508ws |
| PARCEL: 233            | REF:                  |
| TOWN: West Tisbury, MA | DATE: 7/12/2022       |
| SCALE: 1"=20'          |                       |

K:\Proj\2021\102422 to X\_S410 to X\102508\dwg\102508ws.dwg 1/18/2022 5:01:26 PM EST

(3) TRENCHES, EACH TRENCH IS  
45.5' LONG.  
LEACHING CAPACITY =  
 $3 * 45.5' * (2' + 2' + 2') * 0.74 = 606 \text{ GPD}$

IF KEEP EXISTING WELL,  
TRENCHES ARE 37' LONG.  
LEACHING CAPACITY =  
 $3 * 37' * (2' + 2' + 2') * 0.74 = 492 \text{ GPD}$

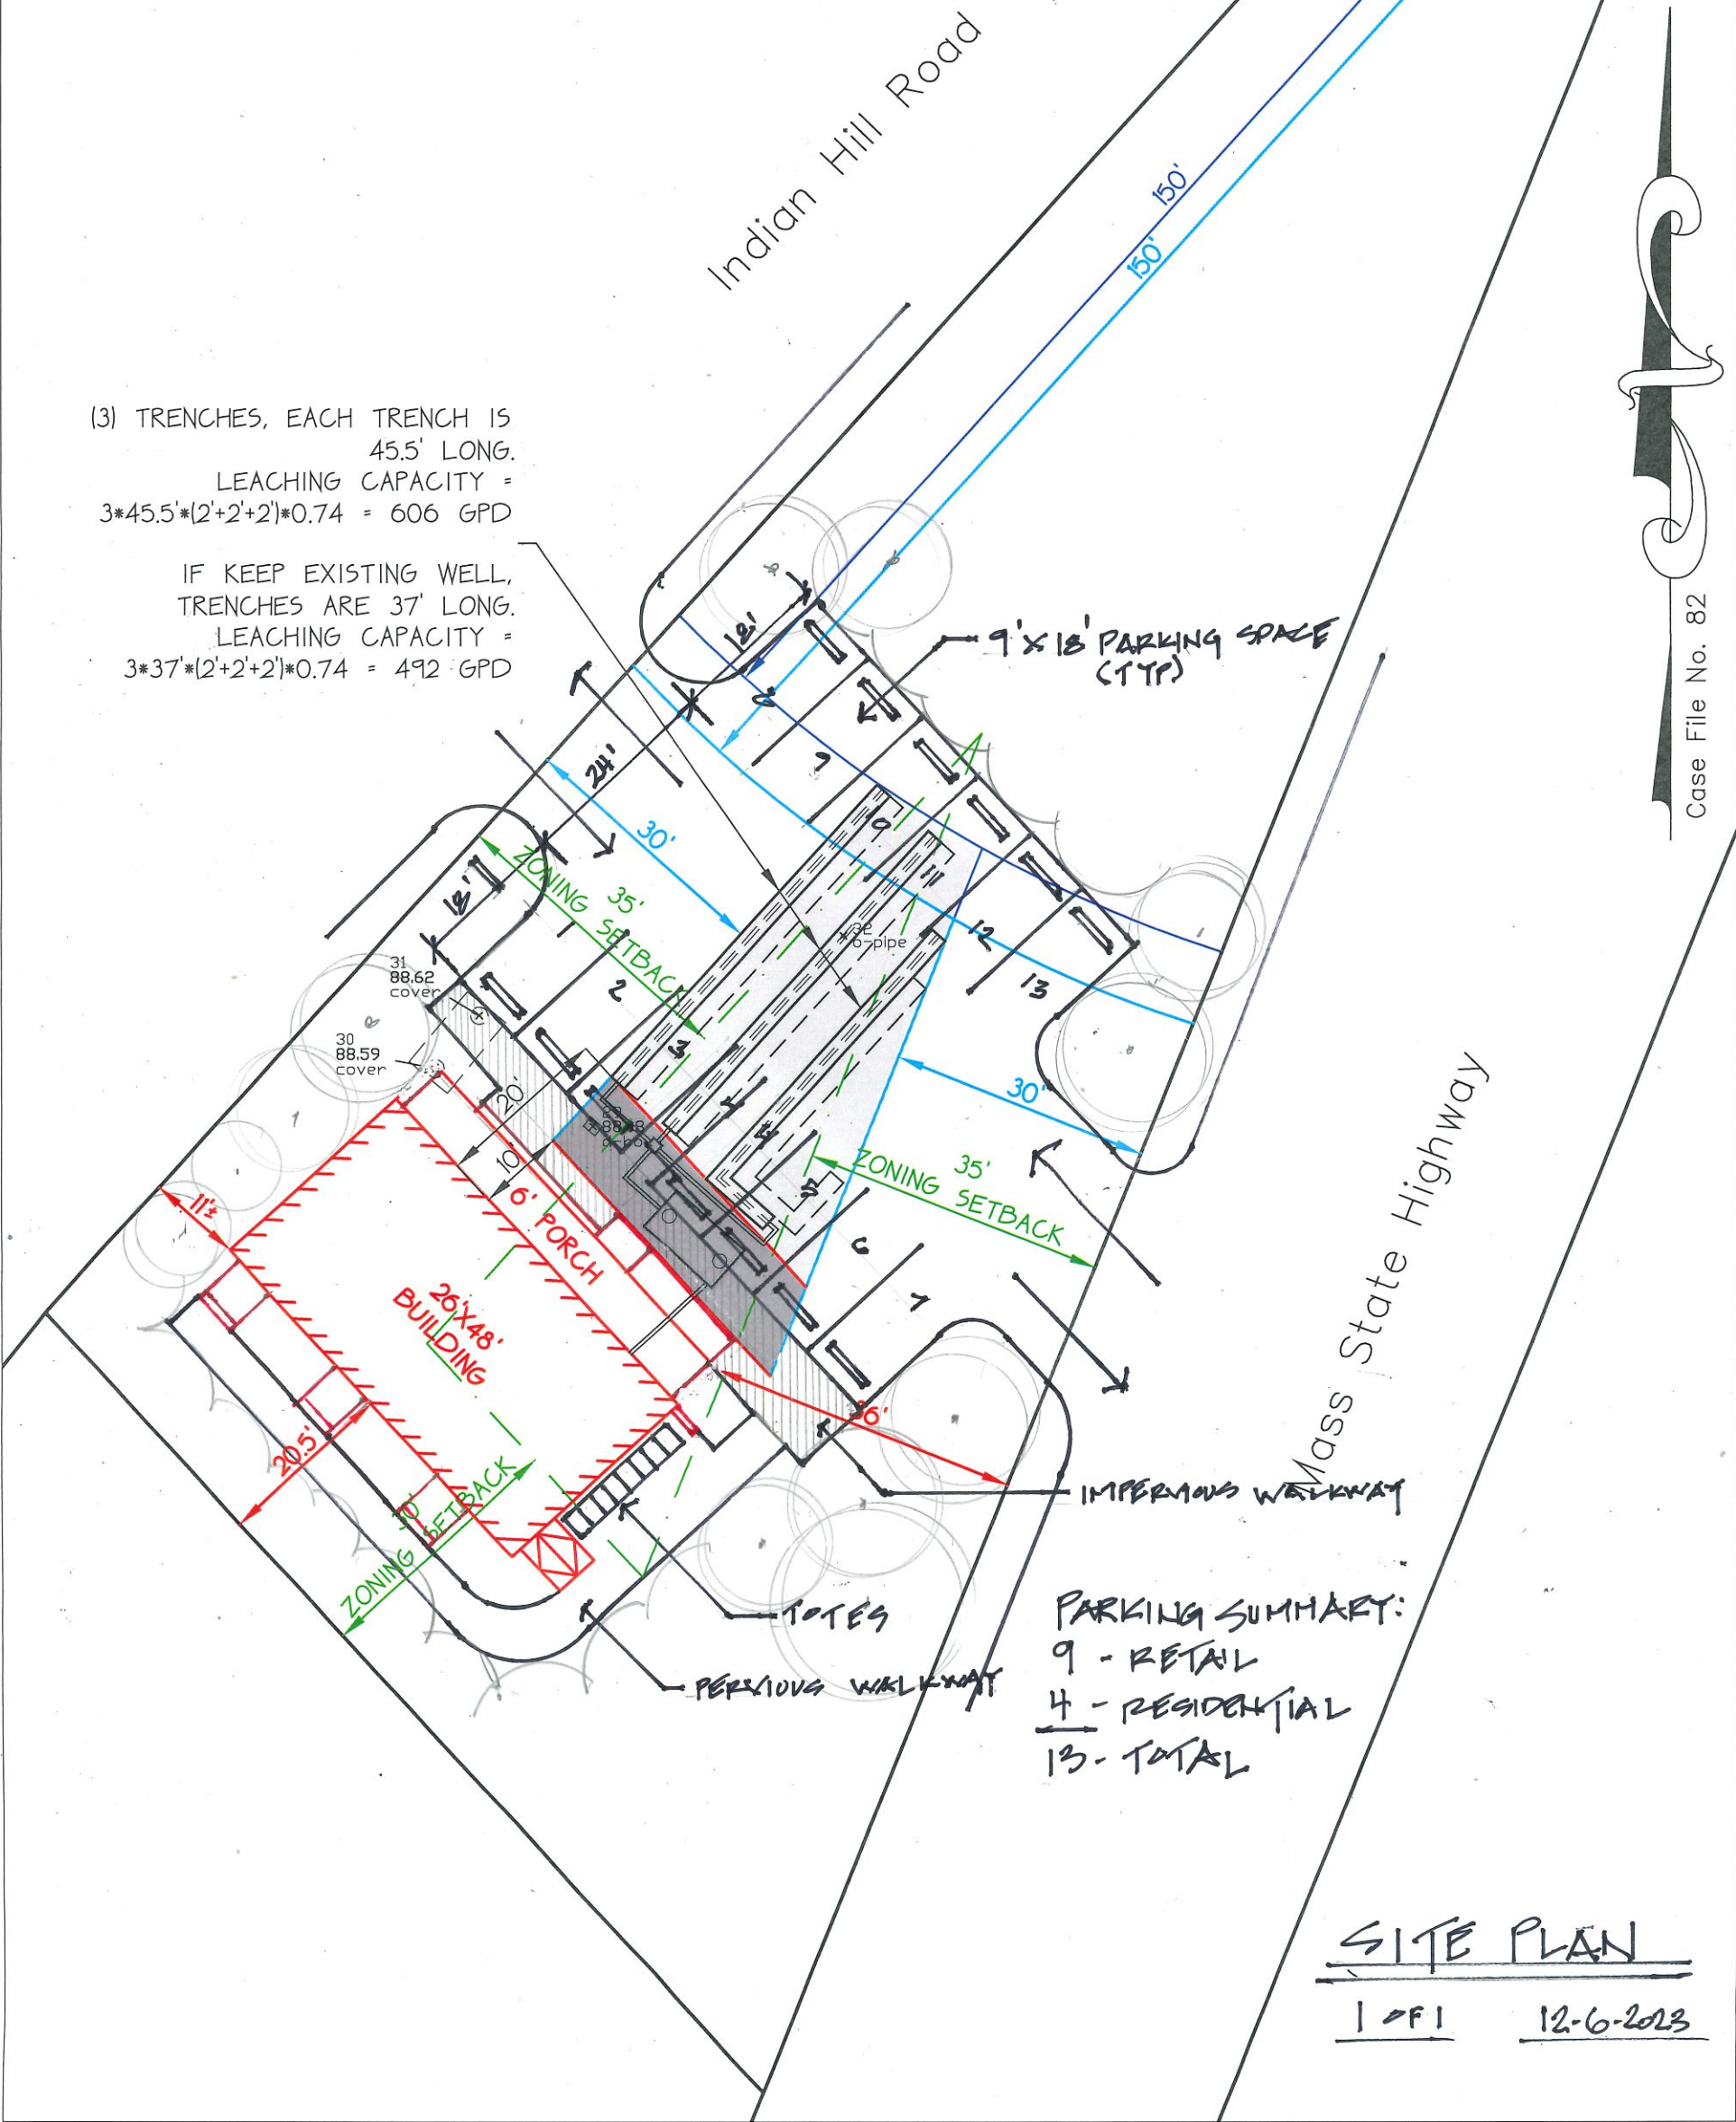

**PARKING SUMMARY:**  
 9 - RETAIL  
 4 - RESIDENTIAL  
 13 - TOTAL

SITE PLAN  
 1 of 1      12-6-2023